





FRONT ELEVATION

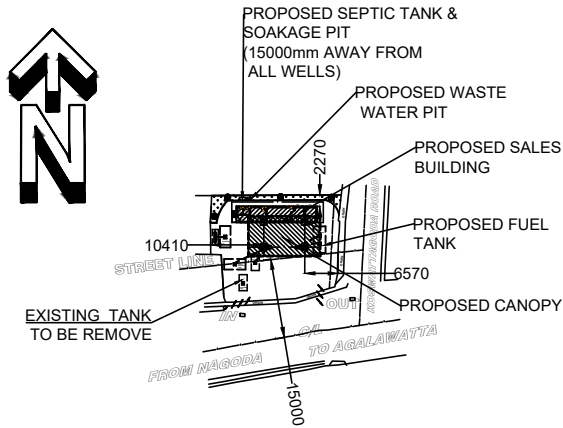

PROPOSED KEY PLAN
SCALE : 1:1000

FLOOR AREA :
CANOPY FLOOR AREA : 126.0 M²
SALES BUILDING AREA : 50.0 M²

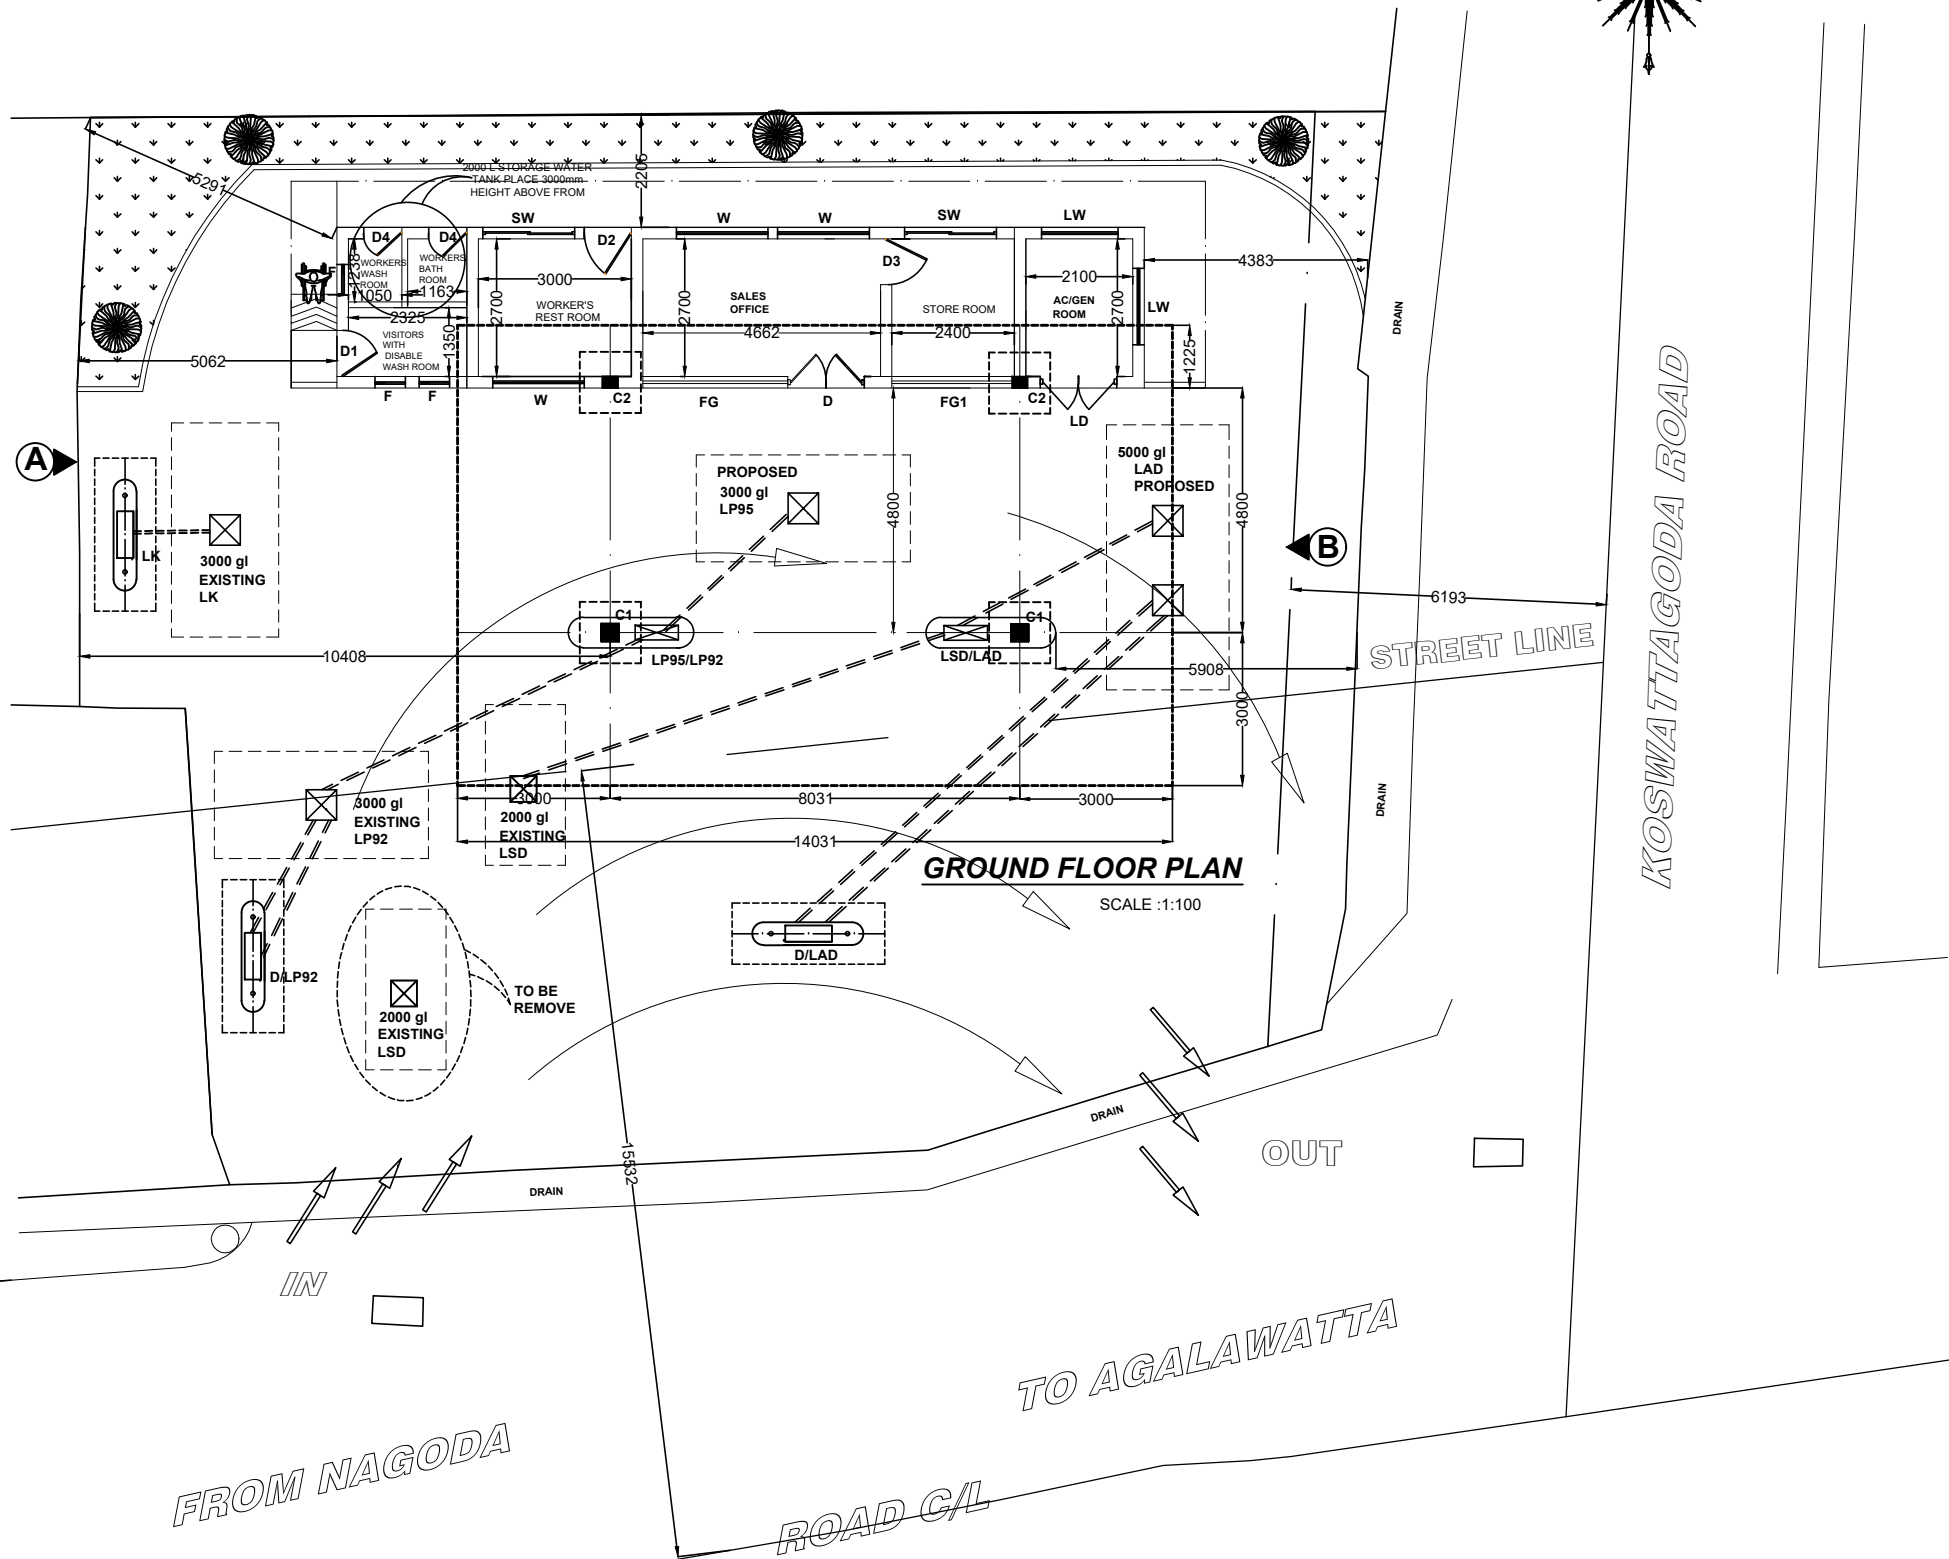

GROUND FLOOR PLAN

SCALE : 1:100

SCHEDULE OF DOORS AND WINDOWS				
TYPE	SIZE	DESCRIPTION	NOs	
D	1200 X 2700	AL FRAMED GLAZED DOOR WITH LOUVERED ABOVE	01	
D1	1050 X 2700	AL FRAMED DOUBLE SIDE ROTATE GLAZED DOOR WITH LOUVERED ABOVE	01	
D2	900 X 2700	AL. FRAMED GLAZED DOOR WITH LOUVERED ABOVE	01	
D3	900 X 2100	AL. FRAMED GLAZED DOOR	01	
D4	750 X 2700	AL. FRAMED GLAZED DOOR WITH LOUVERED ABOVE	02	
LD	1500 X 2700	AL FRAMED LOUVERED DOOR	01	
FG	2800 X 2700	AL. FRAMED FIXED GLAZED WINDOW WITH LOUVERED ABOVE	01	
FG1	2300 X 2700	AL. FRAMED FIXED GLAZED WINDOW WITH LOUVERED ABOVE	01	
LW	1200 X 1800	AL FRAMED LOUVERED WINDOW	02	
W	1800 X 1500	AL FRAMED GLAZED WINDOW WITH LOUVERS ABOVE	03	
SW	1200 X 1500	AL FRAMED GLAZED WINDOW WITH LOUVERS ABOVE	02	
F	600 X 900	AL FRAMED GLAZED FAN LIGHT	03	

PROJECT : **MODIFICATION OF L.F.S.MATHUGAMA -MPCS**

TITLE:



CEYLON PETROLEUM CORPORATION
ENGINEERING DEPARTMENT
NO. 609,
DR. DANISTER DE SILVA MAWATHA,
DEMATAGODA,
COLOMBO -09,
TP. NO. 5661717, 5661818
FAX 5455408

Designed	R.S		
Drawn	C.P	PRABATH	
Checked	R.S		
Approved	G.P.K.Wijekoon Manager (E&P)		
Scale	AS SHOWN	Date:	16.03.2026
Rev.No	Drawing No:	CEYPET/ENG/ 0612	
		Sheet:	03 of 01